

# **Building Permit Requirements**

# **TWO-UNIT DWELLING REGISTRATION & PERMIT APPLICATION GUIDE**

A second unit is a self-contained residential unit located within a house. The unit may be in any part of the house, including the basement. Second units provide an affordable housing option for many people in Brampton.

A second unit is not legal unless it has been registered with the City and any work has been approved and inspected by the City. These policies are intended to make units safe, legal and livable.

This guide explains the process and requirements for submitting an application for registration of a twounit dwelling and submitting a building permit application for the creation of a second dwelling unit in greater detail.

The Two-Unit Dwelling Registration and Building Permit Application processes are consolidated into a single application stream as described below.

# **Pre-application Review and Verification of Zoning Compliance**

Second units are permitted in detached, semi-detached and townhouse dwellings, subject to zoning requirements and restrictions. In order to be legal, second units <u>must be registered</u> with the City of Brampton.

Under the Zoning By-law, the following conditions apply to second dwelling units:

- Only one second unit is permitted in a two-unit dwelling.
- No additional parking is required for the creation of a second unit. The minimum number of parking spaces required by the General Residential Provisions (Section 10.9) of the Zoning By-law must be maintained on the lot.
- The second unit must be smaller in floor area than the principal unit.
- The entrance to the second unit can be located in the side or rear yard provided there is a 1.2m unobstructed path of travel to the principal entrance located entirely on the subject property. A landing serving a second unit entrance must be less than 0.6m above ground level and is limited to a maximum length and width of 0.9m. Steps shall be provided at the front and rear of the landing.
- Two-unit dwellings are not permitted on lands zoned Open Space, Floodplain or within the area identified as the Downtown Floodplain Regulation Area.

# An Application for a Permit must include:

Building permit applications are broken down into 3 major requirements:

- Application Forms
- Construction Drawings
- · Fees

All applications must be applied for online at www.brampton.ca/building

# **Application Forms**

# 1. Application for a Permit to Construct or Demolish

All sections of the form must be completed, including the e-mail address. (This will be our primary means of communication.) Please ensure you include an email address for both the owner and applicant.

# 2. Schedule 1 Designer Form

This form is required when someone other than an Architect or Licensed Professional Engineer is taking responsibility for the design of the second dwelling unit. This person would be either:

- a registered designer with the Building Code Identification Number (BCIN) qualified in House or Small Buildings
- the homeowner taking legal responsibility for the design, provided they understand and are willing to take responsibility for the applicable requirements of the Ontario Building Code.

- 3. Applicable Law Checklist
- 4. <u>Water Pipe Size Plumbing Data Sheet Two-Unit Dwellings</u> <u>Click here to view the form</u>.

# **Construction Drawings**

# Please Note: A legal survey must be included with the construction drawings. Sample drawings

are available <u>here</u>.

The following drawings are required for a Change of Use, Two-Unit Dwelling:

- 1. Legal Survey
- 2. Fully Dimensioned Site Plan Sample Drawing A101
- **3. Existing Floor Layouts** Sample Drawings A102, with designated use of each room or space within the building
- Proposed Floor Layouts Sample Drawings A103 to A105 (basement), A106 (main floor) and A107 (2nd floor),
  - Determine which egress option applies, (refer to sample drawings)
  - Label use of each space, dimensions, ceiling height
  - Show window and door location and sizes
  - Show fire separations
  - Clearly differentiate 'existing' and 'proposed' construction in the floor layout
  - Show location of all heating supply outlets and return air grills, exhaust air intakes and the location of duct-type smoke detectors, within the air handling system serving the entire building
  - Show location of plumbing fixtures
  - Show electrical lighting, control switches and outlets, interconnected smoke alarms and, when required, the location of battery powered emergency lighting units within common means of egress
- 5. Elevations showing Second Unit Entrance and Egress/Exit Windows Sample Drawings A201 and A202
- 6. Sections and Wall/Ceiling/Fire Separation Construction Details including fire rated door assemblies – Sample A301 and A303
- 7. Construction Details of Egress and Escape Windows Sample Drawings A401
- Plumbing Schematic Layout Sample P101, P102 Plumbing schematic drawing with pipe size, location of water meter, proposed sprinkler heads and control valves, including shut off valves to isolate each dwelling unit are for reference only and need <u>not</u> be included with the permit application.

All drawings must be submitted electronically and drawn to an appropriate scale (min 3/16" = 1' or metric equivalent), and clearly legible. All walls must be drawn as double lines (accurately showing wall thickness), and drawings must clearly differentiate between existing and proposed construction. Every page of the drawings shall include the project address and the following designer information:

Homeowner design	- printed name of homeowner, signature and date
Qualified BCIN design	<ul> <li>printed name, individual/firm (if applicable) BCIN numbers, signature and date</li> </ul>
Architect or Professionally Engineered design	<ul> <li>Architect's or Professional Engineer's seal with a signature and date</li> </ul>

\*Due to the complexity involved in designing and constructing a Two-Unit Dwelling in compliance with the Building Code we HIGHLY recommend that a qualified designer prepare the application drawings.

# **Registration Permit Fees**

At the time of submission of the application, registration payment due is **\$200.00** and the permit fee due is **\$1082.43** 

# **Building Permit Issuance**

- 1. Once your application is approved your permit will be issued. Your permit is not issued until you have paid the outstanding permit fees.
- 2. Where an existing water service must be upgraded to meet the increased demand to the house, a connection approval from the municipal water supply to the property line is required. Contact the Region of Peel, Engineering Development Services at <u>siteplanservicing@peelregion.ca</u> for information and arrangements for the new water connection.
- Note regarding sample drawings: The sample drawings do not cover all of the requirements for accessory apartments. The person taking responsibility for the design should refer to the 2012 Ontario Building Code for a detailed listing of all requirements. The most current Building Code is available at e-Laws - Ontario Building Code.
- 4. Construction must be carried out in accordance with the approved permit drawings, including any required changes that are identified through the application review process.
- 5. The approved permit drawings and documents must be kept on site at all times during construction and must be available during inspections. Electronic copies are sufficient.

# **Inspection Requirements**

 You must submit online to arrange for all required inspections. The required inspections will be indicated on the inspection list provided with the issuance of the permit. Inspections are booked by visiting <u>www.brampton.ca/inspections</u>

Typical Second Dwelling Unit inspections can include (depending on the scope of work):

- Underground Plumbing
- Above Ground Plumbing
- Framing
- Insulation & Air Barrier
- HVAC Rough-in
- Occupancy Building, HVAC, Plumbing
- Final Building, HVAC, Plumbing
- Following the successful completion of all required inspections, an Occupancy Permit for the second unit will be issued. Occupancy must be granted to complete the Final Registration of your two-unit dwelling.
- 3. Where construction has previously taken place without a building permit the work may be required to be uncovered so that the inspector can verify compliance with the building code in accordance with the Building Code Act and the inspector's duty of care.

# **Electrical Safety Authority**

Verification of compliance with the Electrical safety Authority (ESA) requirements is mandatory prior to final registration of all second dwelling units in the City of Brampton. The purpose of the ESA review process and inspection is to ensure that the electrical wiring servicing the second unit is safe and properly installed.

If you are not able to obtain an inspection from the ESA (and if no prior ESA inspection was arranged by the old owner), you will need to hire a Licenced Electrical Contractor to inspect the wiring and fixtures and provide written confirmation that all electrical components comply with the Electrical Safety Code. The letter must be on the Electrical Contractor's letterhead and contain their Licence Number.

To find a Licence Electrical Contractor, contact the ESA Customer Service Centre at 1-877-ESA-SAFE (1-877-372-7233).

Or, please use the links on the ESA website:

esasafe.com/compliance/hiring-a-licensed-electrical-contractor/

findacontractor.esasafe.com/

# **Final Registration**

The registration process must be finalized for the Two-Unit Dwelling to be legally registered. Final registration requires an Electrical Safety Authority (ESA) Certificate or an inspection report by a licensed contractor.

Email the ESA Certificate or the inspection report from the licensed contractor to <u>Twounit.Zoning@brampton.ca</u>. Once received and validated, a Two-Unit Registration Certificate will be issued.

# For more information, contact:

Building Division Phone: 905-874-2401 or 311 Email: <u>Twounit.Zoning@brampton.ca</u>

Find information online at www.brampton.ca/EN/residents/Building-Permits/second-dwelling

To check the status of your permit online, visit <u>maps1.brampton.ca/mybrampton</u>

To book an appointment to visit the Building Division, visit <u>www.brampton.ca/skiptheline</u>

To book inspections, visit www.brampton.ca/inspections

# Application for a Permit to Construct or Demolish This form is authorized under subsection 8(1.1) of the *Building Code Act, 1992.*

For use by Principal Authority							
Application number: Permit			number (if differer	nt):			
Date received:		Roll nur	nber:				
Application submitted to: THE CORPORATION OF THE CITY OF BRAMPTON (Name of municipality, upper-tier municipality, board of health or conservation authority)							
A. Project information							
Building number, street name					Unit number		Lot/con.
Municipality	Postal co	de	Plan number/otl	her des	cription		
Project value est. \$			Area of work (m	1 <sup>2</sup> )			
B. Purpose of application							
New construction Addition t existing b		Alterative	ation/repair		Demolition		Conditional Permit
Proposed use of building	(	Current use of	building				
Description of proposed work							
C. Applicant Applicant is:	1		Authorized a	-			
Last name	First nam	ie	Corporation or p	partners	ship		
Street address					Unit number		Lot/con.
Municipality	Postal co	de	Province		E-mail		
Telephone number	Fax				Cell number		
D. Owner (if different from applicant)							
Last name     First name     Corporation or partnership							
Street address	1		1		Unit number		Lot/con.
Municipality	Postal co	de	Province		E-mail	I	
Telephone number	Fax				Cell number		

E. Builder (optional)							
Last name	First name	Corporation or partners	hip (if applicable)				
Street address			Unit n	umber	Lc	t/con.	
Municipality	Postal code	Province	E-mai	I	L		
Telephone number	Fax		Cell n	umber			
F. Tarion Warranty Corporation (Ontario	o New Home Warrant	y Program)	1				
i. Is proposed construction for a new hom <i>Plan Act</i> ? If no, go to section G.	ne as defined in the Onta	rio New Home Warranties	S		Yes		No
ii. Is registration required under the Ontar	io New Home Warranties	s Plan Act?			Yes		No
iii. If yes to (ii) provide registration number	:(s):						
G. Required Schedules							
i) Attach Schedule 1 for each individual who rev	views and takes responsi	bility for design activities.					
ii) Attach Schedule 2 where application is to con	struct on-site, install or re	epair a sewage system.					
H. Completeness and compliance with	applicable law						
i) This application meets all the requirements of clauses 1.3.1.3 (5) (a) to (d) of Division C of the Building Code (the application is made in the correct form and by the owner or authorized agent, all applicable fields have been completed on the application and required schedules, and all required schedules are submitted).					No		
Payment has been made of all fees that are required, under the applicable by-law, resolution or regulation made under clause 7(1)(c) of the <i>Building Code Act, 1992</i> , to be paid when the application Yes Yes I Not is made.						No	
<li>ii) This application is accompanied by the plans resolution or regulation made under clause 7</li>			/-law,		Yes		No
					No		
iv) The proposed building, construction or demo	ition will not contravene	any applicable law.			Yes		No
I. Declaration of applicant							
1				(	declare	e that:	
(print name)							
<ol> <li>The information contained in this application, attached schedules, attached plans and specifications, and other attached documentation is true to the best of my knowledge.</li> <li>If the owner is a corporation or partnership, I have the authority to bind the corporation or partnership.</li> </ol>							
Date	Signature of applicant						

Personal information contained in this form and schedules is collected under the authority of subsection 8(1.1) of the *Building Code Act, 1992*, and will be used in the administration and enforcement of the *Building Code Act, 1992*. Questions about the collection of personal information may be addressed to: a) the Chief Building Official of the municipality or upper-tier municipality to which this application is being made, or, b) the inspector having the powers and duties of a chief building official in relation to sewage systems or plumbing for an upper-tier municipality, board of health or conservation authority to whom this application is made, or, c) Director, Building and Development Branch, Ministry of Municipal Affairs and Housing 777 Bay St., 2nd Floor. Toronto, M5G 2E5 (416) 585-6666.

# **Schedule 1: Designer Information**

Use one form for each individual who reviews and takes responsibility for design activities with respect to the project.

A. Project Information				
Building number, street name			Unit no.	Lot/con.
Municipality	Postal code	Plan number/ other descript	tion	•
B. Individual who reviews and takes	s responsibilit	ty for design activities		
Name	-	Firm		
Street address			Unit no.	Lot/con.
Municipality	Postal code	Province	E-mail	•
Telephone number	Fax number		Cell number	
C. Design activities undertaken by i Division C]	ndividual ide	ntified in Section B. [Bui	Iding Code Table	e 3.5.2.1. of
<ul> <li>House</li> <li>Small Buildings</li> <li>Large Buildings</li> <li>Complex Buildings</li> <li>Description of designer's work</li> </ul>		g Services on, Lighting and Power	<ul> <li>Building Stru</li> <li>Plumbing –</li> <li>Plumbing –</li> <li>On-site Sew</li> </ul>	House
D. Declaration of Designer				
		do	clare that (choose c	no as appropriato):
print name	5)	ue		
I review and take responsibility C, of the Building Code. I am of Individual BCIN: Firm BCIN:	qualified, and the	e firm is registered, in the app		
I review and take responsibility under subsection 3.2.5.of Division Individual BCIN:	sion C, of the Bu	uilding Code.	priate category as a	n "other designer"
<ul> <li>The design work is exempt fro Basis for exemption from</li> <li>I certify that:         <ol> <li>The information contained in this s</li> <li>I have submitted this application w</li> </ol> </li> </ul>	registration and chedule is true t	qualification: o the best of my knowledge.	ents of the Building (	Code.
Date		Signature of Designer		
NOTE:				

- 1. For the purposes of this form, "individual" means the "person" referred to in Clause 3.2.4.7(1) (c).of Division C, Article 3.2.5.1. of Division C, and all other persons who are exempt from qualification under Subsections 3.2.4. and 3.2.5. of Division C.
- Schedule 1 is not required to be completed by a holder of a license, temporary license, or a certificate of practice, issued by the Ontario Association of Architects. Schedule 1 is also not required to be completed by a holder of a license to practise, a limited license to practise, or a certificate of authorization, issued by the Association of Professional Engineers of Ontario.

#### **CITY OF BRAMPTON - BUILDING DIVISION**

#### SECTION GL. DOCUMENTS ESTABLISHING COMPLIANCE WITH APPLICABLE LAW (OBC Div. A - 1.4.1.3.)

Permit Application No.	Project Location		
	#	street	unit/suite

#### Explanation:

Applicable Law - Applicable law is other regulations for which approval must be obtained before a building permit can issue. A complete list of Acts and Regulations that are "Applicable Law" is set out in Article 1.4.1.3 of Division A of the Ontario Building Code.

#### Instructions:

The most common Acts and Regulations are listed below with the documentation that must be provided before a building permit can issue. Check those that apply to your permit application and complete the declaration. The customer service plans examiner will assist you with any questions you may have about the regulations listed. The documents noted <u>must</u> be provided before a building permit can issue.

#### **Details and Contact Information**

A list of agencies and contact information is available at the Building Division or on the City of Brampton website

#### APPLICABLE LAWS (Note: This list provides only the most common approvals)

ACT	Description	REQUIRED DOCUMENTS (Provide copy)	Required Yes/No	Received
Planning Act s.41	(Site Plan Control)	Site plan approved drawings		
Planning Act s.34	(Zoning By-law)	Final & binding amendment		
Planning Act Pt. V1	(Division of Land)	Registered Plan or Deed		
Planning Act s.45	(Minor Variance)	Final Decision from City Clerk		
Planning Act s.33	(Demolition of Residential Property)	Council Approval		
Ontario Heritage Act ss.27 (3), 30(2), 33	3, ss.34.40.1 & 40.2	Heritage Permit		
Ontario Heritage Act s.34.5 and s. 34.7.	(2)	Ministry of Culture approval		
Development Charges Act s.28 and s.53, Education Act s.257.83 & 257.93	(Financial Contribution)	Confirmation of payment from City of Brampton Finance Department		
Planning Act s.42(6)	(Cash in Lieu of Parkland)	Confirmation of payment from City of Brampton Finance Department		
Conservation Authorities Act	(Flood plain or fill regulated area)	Construction and Fill Permit		
Day Nurseries Act, Reg. 262 s.5	(Daycare centre with more than 5 children)	Approval from Ministry of Children and Youth Services		
Education Act s.194	(Demolition of all or part of a school)	Approval from Ministry of Education		
Environmental Protection Act s.168.3.1 & 168.6(1) change of use of land	(Industrial or commercial to agricultural, residential or park)	File Record of Site Condition (RSC) and/or provide Certification of Property use (CPU)		
Public Transportation Act s.34 and s. 38 10	(Construction within 45m of the road or within 395m of an intersection of Hwys, 410 or 407)	Building and Land Use Permit issued by MTO		
Other:				

APPLICANT'S DECLARATION

Ι,

\_\_\_\_\_ certify that the applicable laws designated on the above noted chart are, to the best of my (print name)

Signature

knowledge, all of the "applicable law" for which this application for a permit must comply before a permit is issued.

Date

FOR OFFICE USE ONLY


# PROPOSED SECOND UNIT 123 ANYWHERE STREET, BRAMPTON, ONTARIO

# DRAWING LIST:

PROVIDE SURVEY (FOR REFERENCE ONLY)

A101	SAMPLE SITE PLAN	
A102 A103	SAMPLE EXISTING BASEMENT PLAN SAMPLE BASEMENT PLAN - OPTION 'A'	
A104 A105 A106 A107	SAMPLE BASEMENT PLAN - OPTION 'B' SAMPLE BASEMENT PLAN - OPTION 'C' SAMPLE GROUND FLOOR PLAN SAMPLE SECOND FLOOR PLAN	EGRESS OPTIC
A201 A202	SAMPLE SIDE ELEVATION SAMPLE REAR ELEVATION	REQUIREMEN EGRESS IN OF
A301 A302	SAMPLE SECTIONS WALL/ CEILING DETAILS	
A401 A402	WINDOW DETAILS FIRE BLOCKING DETAILS	
P101 P102 123 ANYWHERE STI	SAMPLE BASEMENT PLAN - PLUMBING SAMPLE BASEMENT PLAN - RISERS	

123 ANYWHERE STREET, BRAMPTON

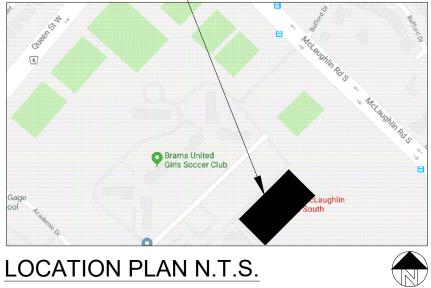



ION 'C' IS ONLY AVAILABLE AS A **ALTERNATIVE WHERE ZONING** NTS CANNOT BE ACHIEVED FOR PTIONS 'A' OR 'B'


> **CHANGE OF USE - TWO UNIT HOUSE** SAMPLE SITE PLAN JUNE 8th. 2019




CITY OF BRAMPTON, ON 8850 McLaughlin RD. UNIT #1 PLANNING AND INFRASTRUCTURE SERVICES

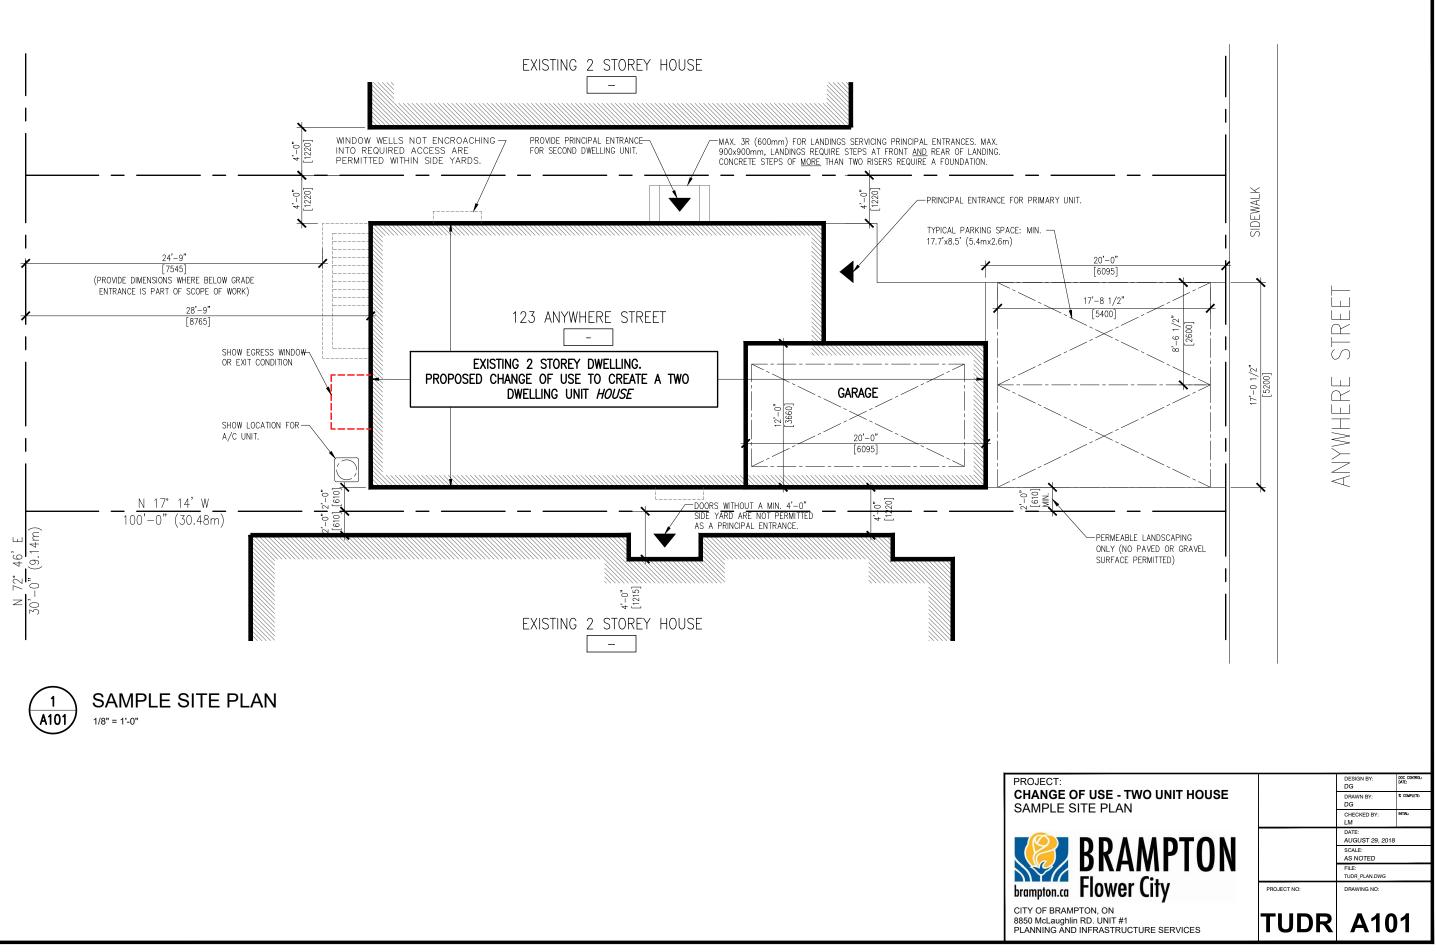


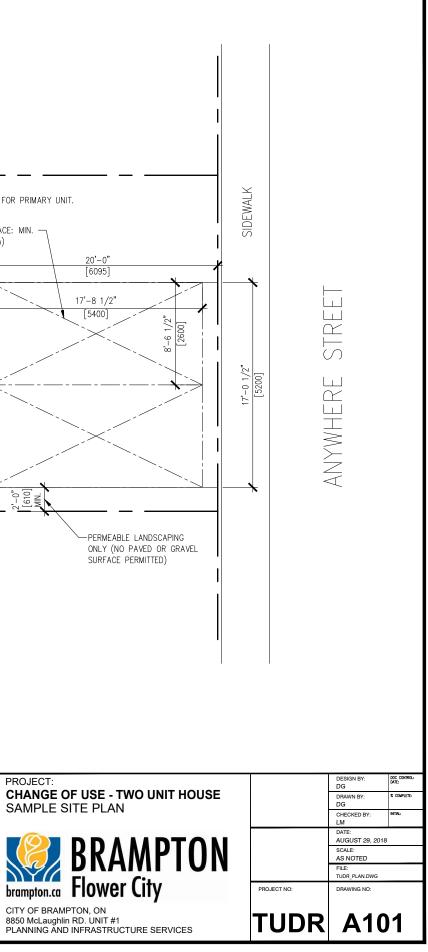

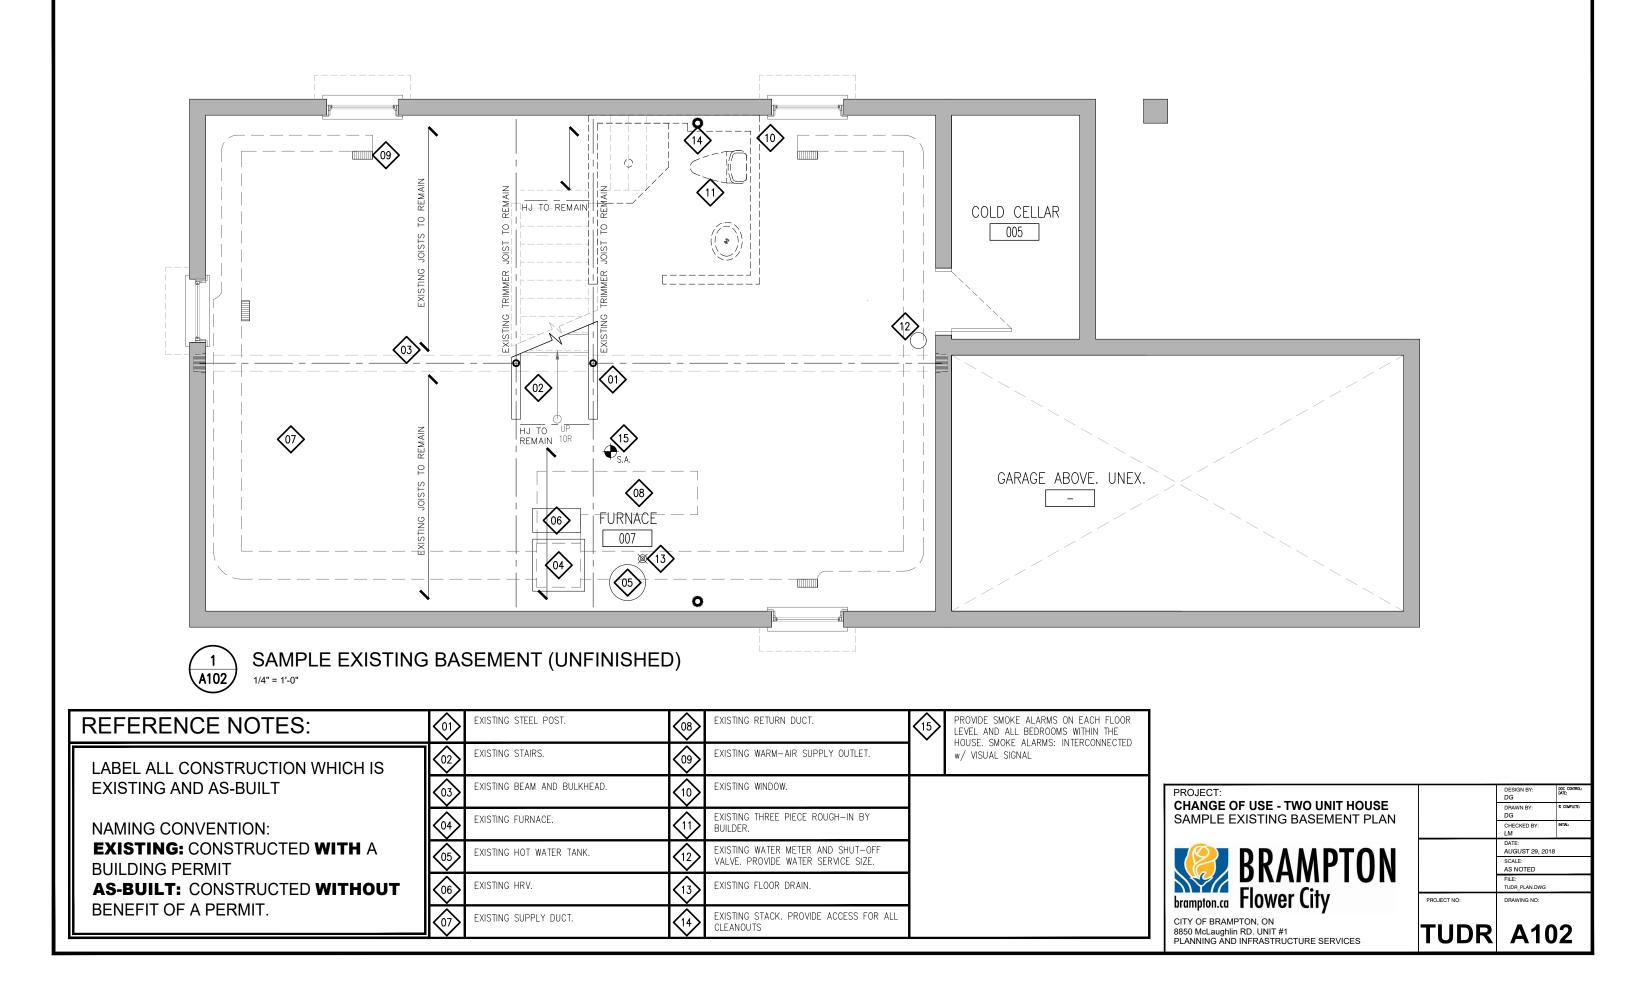



y	2 A301 37'-9"	P T
CH:7'-8' CH:7'-	W/D W/D W/D W/D W/D W/D W/D W/D	JNEX.
REFERENCE NOTES:	PROVIDE ALL ROOM NAMES. NOTE AT A MINIMUM DWELLING UNITS REQUIRE LIVING, DINING, KITCHEN, BATHROOM AND BEDROOM(S). PROVIDE SUPPLY GRILLES IN ALL ROOMS AND A RETURN AIR IN E UNIT ON ALL FLOORS. RETURNS: NOT PERMITTED IN FIRE SEPARA	TIONS.
EGRESS OPTION 'A' EGRESS FROM THE BASEMENT UNIT BY WAY OF A BELOW GRADE ENTRANCE, WALK-OUT CONDITION <u>OR</u> INTERIOR STAIR,	PROVIDE DETAILS OF ALL PROPOSED WALL TYPES INCLUDING WALL       PROVIDE FIRE SEPARATIONS BETWEEN SUITES, COMMON AREAS AN CEILING ASSEMBLIES         PROVIDE ELECTRICAL LIGHTING IN EACH ROOM AND WALL SWITCHES.       PROVIDE ELECTRICAL LIGHTING IN EACH ROOM AND WALL SWITCHES.	U ALL
PROVIDING ACCESS TO THE EXTERIOR, EXCLUSIVE TO THE SECOND UNIT.	PROVIDE A 3-WAY SWITCH AT THE TOP AND BOTTOM OF STAIRS.	.UDE ALL S
PROVIDE DETAILS FOR ALL PROPOSED CONSTRUCTION AND ALL	WITHIN THE HOUSE. SMOKE ALARMS: INTERCONNECTED w/ VISUAL SIGNAL 44 RELEVANT EXISTING AND PROPOSED STRUCTURAL INFORMATION.	A
CONSTRUCTION BUILT WITHOUT BENEFIT OF A BUILDING PERMIT.	AND SELF CLOSING DEVICES. DOORS TO GARAGES SHALL BE GAS PROOF. US GAS AND ELECTRICITY TO THE FURNACE UPON ACTIVATION.	
<ul> <li>(5%) AND BEDROOMS (2.5%)</li> <li>PROVIDE CEILING HEIGHT UNDER BULKHEADS AND AT LOWEST POINTS.</li> <li>MINIMUM CEILING HEIGHT BEOLUER IS 1050mm (6', 5") THROLUCHOUT.</li> </ul>	AS-BUILT (IF CONSTRUCTED WITHOUT BENEFIT OF A PERMIT).	br
MINIMUM CEILING HEIGHT REQUIRED IS 1950mm (6'-5") THROUGHOUT.	ROOMS NOT EQUIPPED WITH A WINDOW PROVIDING NATURAL VENTILATION.	88 PL

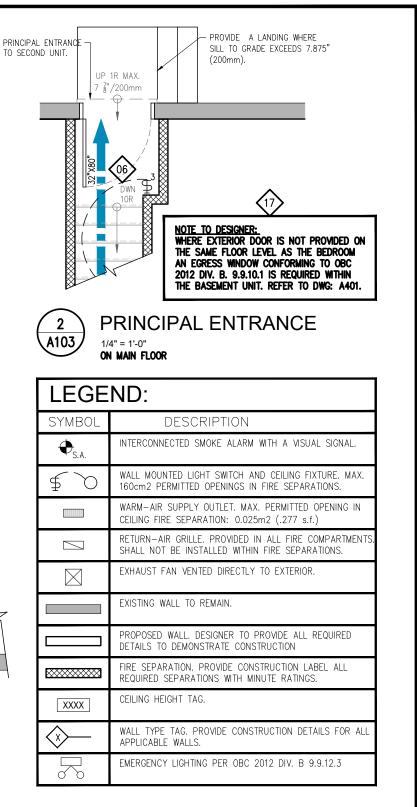

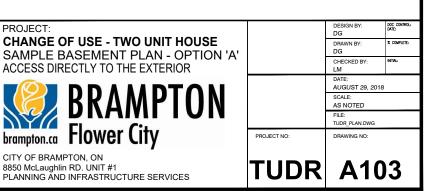

<b>1</b> <b>A104</b> SAMPLE PROPOSE 1/4" = 1'-0"	ED E	ASEMENT PLAN - OPTION 'B'			
REFERENCE NOTES:		PROVIDE ALL ROOM NAMES. NOTE AT A MINIMUM DWELLING UNITS REQUIRE LIVING, DINING, KITCHEN, BATHROOM AND BEDROOM(S).		PROVIDE SUPPLY GRILLES IN ALL ROOMS AND A RETURN AIR IN EACH UNIT ON ALL FLOORS. RETURNS: NOT PERMITTED IN FIRE SEPARATIONS.	
EGRESS OPTION 'B' EGRESS FROM THE BASEMENT UNIT THROUGH A SHARED.		PROVIDE DETAILS OF ALL PROPOSED WALL TYPES INCLUDING WALL CONSTRUCTION APPLIED TO EX. EXTERIOR WALLS. INSULATION, VB ETC.		PROVIDE FIRE SEPARATIONS BETWEEN SUITES, COMMON AREAS AND ALL CEILING ASSEMBLIES.	
PROTECTED STAIRWAY WHICH DOES NOT INVOLVE ENTERING ANOTHER UNIT OR AN AREA DEDICATED FOR ANOTHER PURPOSE		PROVIDE ELECTRICAL LIGHTING IN EACH ROOM AND WALL SWITCHES. PROVIDE A 3-WAY SWITCH AT THE TOP AND BOTTOM OF STAIRS.		DIMENSION ALL ROOMS, SPACES AND PROPOSED CONSTRUCTION.	PF C
(IE: LAUNDRY/ GARAGE etc.) WHICH LEADS TO THE EXTERIOR.		PROVIDE SMOKE ALARMS ON EACH FLOOR LEVEL AND ALL BEDROOMS WITHIN THE HOUSE. SMOKE ALARMS: INTERCONNECTED $w/$ VISUAL SIGNAL		ALL NEW OR ENLARGED OPENINGS SHALL BE DECLARED AND INCLUDE ALL RELEVANT EXISTING AND PROPOSED STRUCTURAL INFORMATION.	S
PROVIDE DETAILS FOR ALL PROPOSED CONSTRUCTION AND ALL CONSTRUCTION BUILT WITHOUT BENEFIT OF A BUILDING PERMIT.		PROVIDE DOOR SIZES. LABEL ALL FIRE RATED DOORS $w/$ MINUTE RATING AND SELF CLOSING DEVICES. DOORS TO GARAGES SHALL BE GAS PROOF.		PROVIDE A DUCT-TYPE SMOKE DETECTOR WHICH WOULD SHUT OFF THE GAS AND ELECTRICITY TO THE FURNACE UPON ACTIVATION.	
PROVIDE ALL DAYLIGHT REQUIREMENTS FOR LIVING AND DINING ROOM (5%) AND BEDROOMS (2.5%)		PROVIDE WINDOW SIZES AND LABEL AS EITHER: EXISTING, PROPOSED OR AS-BUILT (IF CONSTRUCTED WITHOUT BENEFIT OF A PERMIT).	16	PROVIDE AN EGRESS WINDOW FOR BEDROOMS PER OBC 2012 DIV. B.9.9.10.1. REFER TO DWG: A401 FOR DETAILS.	br
PROVIDE CEILING HEIGHT UNDER BULKHEADS AND AT LOWEST POINTS. MINIMUM CEILING HEIGHT REQUIRED IS 1950mm (6'-5") THROUGHOUT.		PROVIDE EXHAUST FANS OVER RANGES, WITHIN BATHROOMS AND ALL ROOMS NOT EQUIPPED WITH A WINDOW PROVIDING NATURAL VENTILATION.		REQUIRED CLOSURE. MINIMUM 20min. RATED DOOR w/ SELF CLOSING DEVICE. PROVIDE SMOKE-TIGHT SEAL.	CI <sup>-</sup> 88
					PL

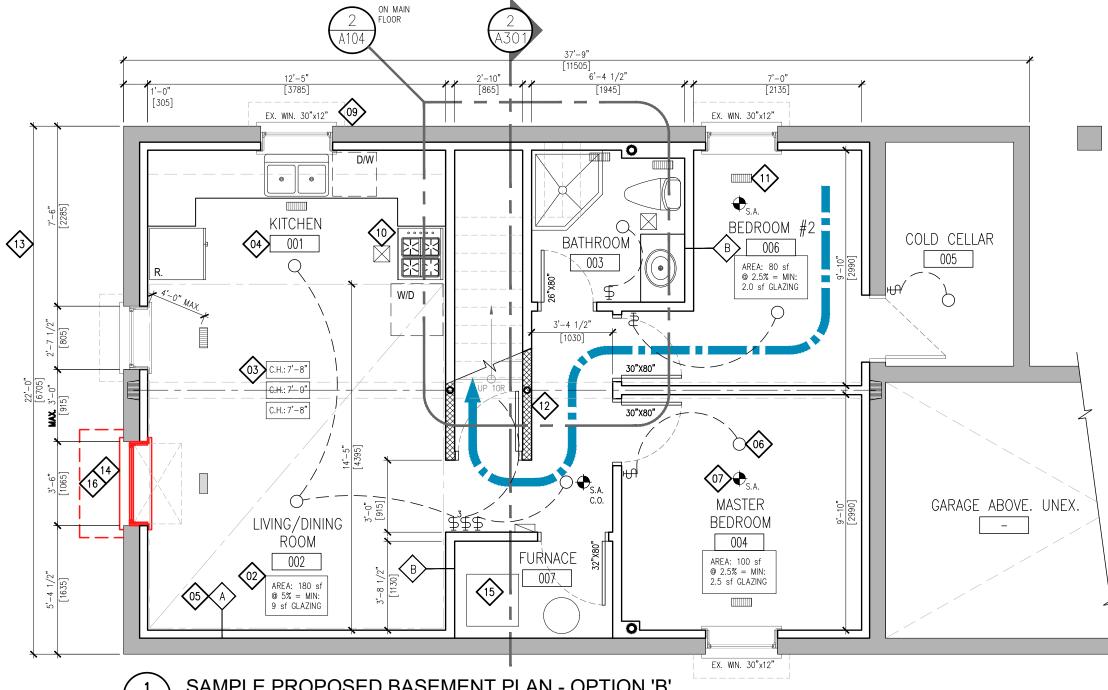

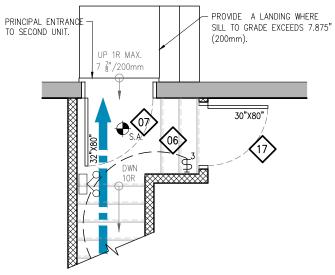


2 A104

(SHARED MEANS OF EGRESS) PRINCIPAL ENTRANCE 1/4" = 1'-0"

ON MAIN FLOOR


LEGE	ND:
SYMBOL	DESCRIPTION
€ <sub>S.A.</sub>	INTERCONNECTED SMOKE ALARM WITH A VISUAL SIGNAL.
€ Ò	WALL MOUNTED LIGHT SWITCH AND CEILING FIXTURE. MAX. 160cm2 PERMITTED OPENINGS IN FIRE SEPARATIONS.
	WARM-AIR SUPPLY OUTLET. MAX. PERMITTED OPENING IN CEILING FIRE SEPARATION: 0.025m2 (.277 s.f.)
	RETURN-AIR GRILLE. PROVIDED IN ALL FIRE COMPARTMENTS. SHALL NOT BE INSTALLED WITHIN FIRE SEPARATIONS.
$\square$	EXHAUST FAN VENTED DIRECTLY TO EXTERIOR.
	EXISTING WALL TO REMAIN.
	PROPOSED WALL. DESIGNER TO PROVIDE ALL REQUIRED DETAILS TO DEMONSTRATE CONSTRUCTION
	FIRE SEPARATION. PROVIDE CONSTRUCTION LABEL ALL REQUIRED SEPARATIONS WITH MINUTE RATINGS.
XXXX	CEILING HEIGHT TAG.
$\bigcirc$	WALL TYPE TAG. PROVIDE CONSTRUCTION DETAILS FOR ALL APPLICABLE WALLS.
$\sim$	EMERGENCY LIGHTING PER OBC 2012 DIV. B 9.9.12.3

DJECT:		DESIGN BY: DG	DOC CONTROL: DATE:
<b>ANGE OF USE - TWO UNIT HOUSE</b> MPLE BASEMENT PLAN - OPTION 'B'		DRAWN BY: DG	% COMPLETE:
CESS TO EXTERIOR ON ANOTHER FLOOR		CHECKED BY: LM	INITIAL:
		DATE: AUGUST 29, 2018	
🕖 BRAMPTON		SCALE: AS NOTED	
		FILE: TUDR_PLAN.DWG	
npton.ca Flower City	PROJECT NO:	DRAWING NO:	
Y OF BRAMPTON, ON DMcLaughlin RD. UNIT #1 NNING AND INFRASTRUCTURE SERVICES	TUDR	A10	)4

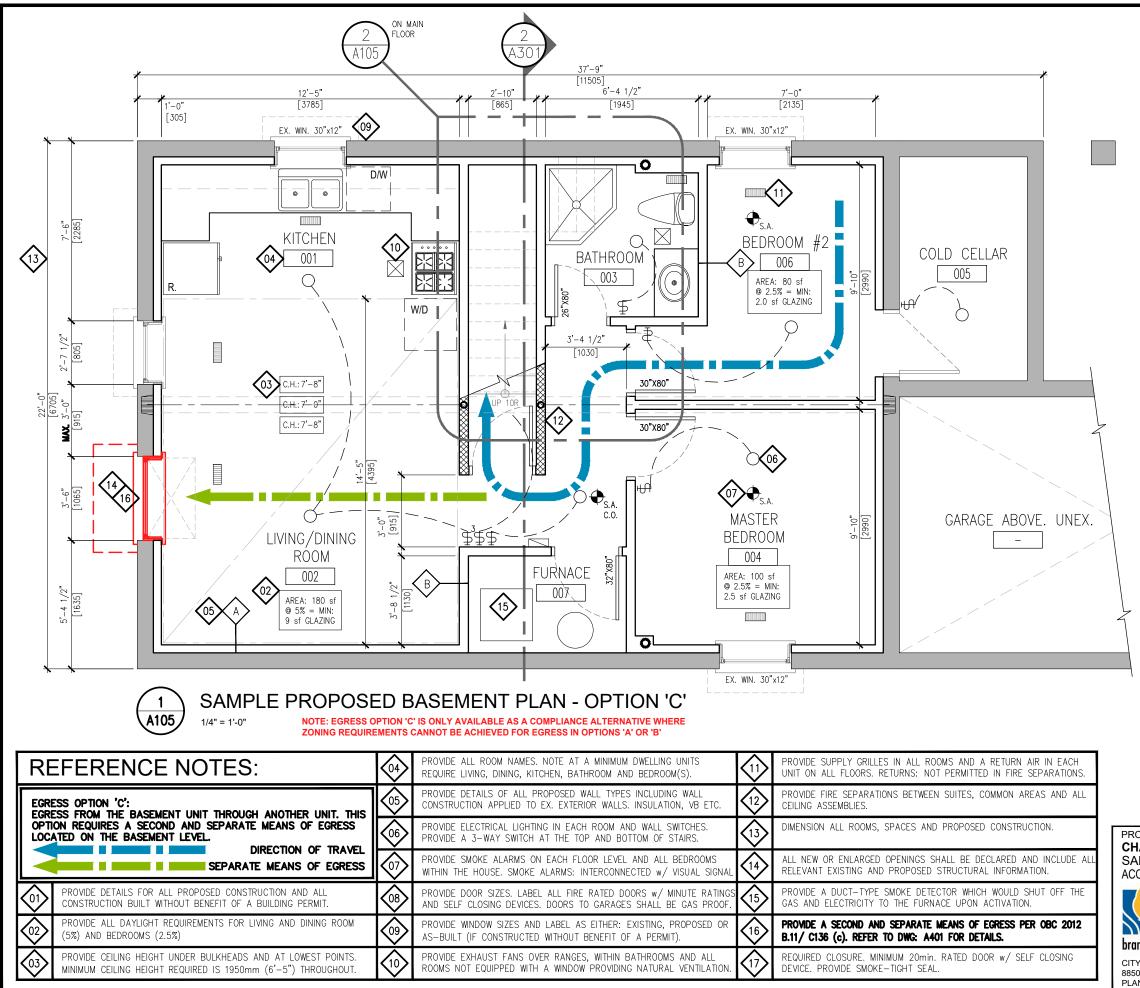

CITY 8850 PLAN

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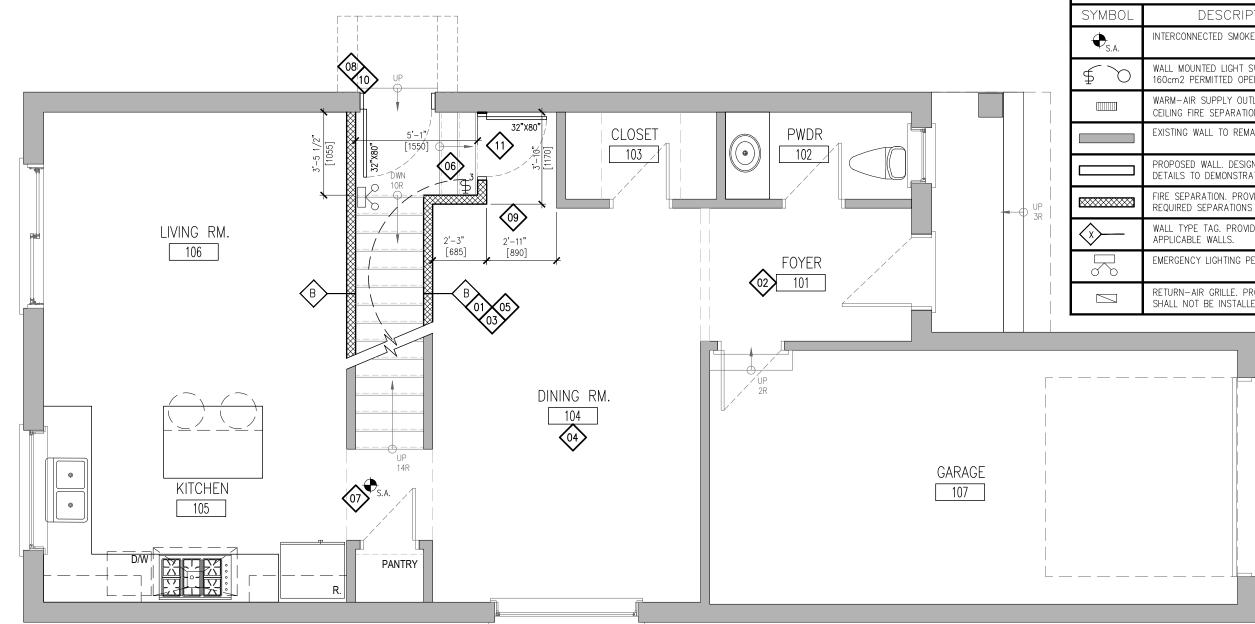

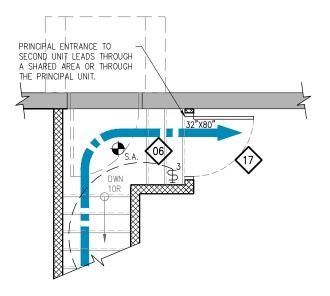
# PRINCIPAL ENTRANCE

1/4" = 1'-0" ON MAIN FLOOR - THROUGH ANOTHER UNIT

LEGE	ND:
SYMBOL	DESCRIPTION
€ <sub>S.A.</sub>	INTERCONNECTED SMOKE ALARM WITH A VISUAL SIGNAL.
\$	WALL MOUNTED LIGHT SWITCH AND CEILING FIXTURE. MAX. 160cm2 PERMITTED OPENINGS IN FIRE SEPARATIONS.
	WARM-AIR SUPPLY OUTLET. MAX. PERMITTED OPENING IN CEILING FIRE SEPARATION: 0.025m2 (.277 s.f.)
	RETURN-AIR GRILLE. PROVIDED IN ALL FIRE COMPARTMENTS. SHALL NOT BE INSTALLED WITHIN FIRE SEPARATIONS.
$\square$	EXHAUST FAN VENTED DIRECTLY TO EXTERIOR.
	EXISTING WALL TO REMAIN.
	PROPOSED WALL. DESIGNER TO PROVIDE ALL REQUIRED DETAILS TO DEMONSTRATE CONSTRUCTION
	FIRE SEPARATION. PROVIDE CONSTRUCTION LABEL ALL REQUIRED SEPARATIONS WITH MINUTE RATINGS.
XXXX	CEILING HEIGHT TAG.
	WALL TYPE TAG. PROVIDE CONSTRUCTION DETAILS FOR ALL APPLICABLE WALLS.
$\sim$	EMERGENCY LIGHTING PER OBC 2012 DIV. B 9.9.12.3

DJECT:		DESIGN BY: DG	DOC CONTROL: DATE:
ANGE OF USE - TWO UNIT HOUSE MPLE BASEMENT PLAN - OPTION 'C'		DRAWN BY: DG	% COMPLETE:
CESS TO EXTERIOR THRU PRINCIPAL UNIT		CHECKED BY: LM	INITIAL:
		DATE: AUGUST 29, 2018	
🕖 BRAMPTON		SCALE: AS NOTED	
		FILE: TUDR_PLAN.DWG	
npton.ca Flower City	PROJECT NO:	DRAWING NO:	
OF BRAMPTON, ON	TUDD		
McLaughlin RD. UNIT #1 NNING AND INFRASTRUCTURE SERVICES	TUDR	A10	15







SAMPLE GROUND FLOOR PLAN 1/4" = 1'-0"

R	EFERENCE NOTES:		PROVIDE SMOKE ALARMS ON EACH FLOOR LEVEL AND ALL BEDROOMS WITHIN THE HOUSE. SMOKE ALARMS: INTERCONNECTED w/ VISUAL SIGNAL
	PROVIDE DETAILS FOR ALL PROPOSED CONSTRUCTION AND ALL CONSTRUCTION BUILT WITHOUT BENEFIT OF A BUILDING PERMIT.		PROVIDE DOOR SIZES. LABEL ALL FIRE RATED DOORS $w/$ MINUTE RATINGS AND SELF CLOSING DEVICES. DOORS TO GARAGES SHALL BE GAS PROOF.
	PROVIDE SUPPLY GRILLES IN ALL ROOMS AND A RETURN AIR IN EACH UNIT ON ALL FLOORS. RETURNS: NOT PERMITTED IN FIRE SEPARATIONS.	<b>()9)</b>	DIMENSION ALL ROOMS, SPACES AND PROPOSED CONSTRUCTION.
	PROVIDE FIRE SEPARATIONS BETWEEN SUITES, COMMON AREAS AND ALL CEILING ASSEMBLIES. VERTICAL: MIN. 30min/ HORIZONTAL: 15min.		ALL NEW OR ENLARGED OPENINGS SHALL BE DECLARED AND INCLUDE ALL RELEVANT EXISTING AND PROPOSED STRUCTURAL INFORMATION.
04	PROVIDE ALL ROOM NAMES. NOTE AT A MINIMUM DWELLING UNITS REQUIRE LIVING, DINING, KITCHEN, BATHROOM AND BEDROOM(S).		REQUIRED CLOSURE. MINIMUM 20min. RATED DOOR w/ SELF CLOSING DEVICE. PROVIDE SMOKE-TIGHT SEAL.
	PROVIDE DETAILS OF ALL PROPOSED WALL TYPES INCLUDING WALL CONSTRUCTION APPLIED TO EX. EXTERIOR WALLS. INSULATION, VB ETC.		
	PROVIDE ALL ELECTRICAL LIGHTING FACILITIES AND WALL SWITCHES. PROVIDE A 3-WAY SWITCH AT THE TOP AND BOTTOM OF STAIRS.		

	LEGE	ND:
	SYMBOL	DESCRIPTION
	€ <sub>S.A.</sub>	INTERCONNECTED SMOKE ALARM WITH A VISUAL SIGNAL.
	\$ D	WALL MOUNTED LIGHT SWITCH AND CEILING FIXTURE. MAX. 160cm2 PERMITTED OPENINGS IN FIRE SEPARATIONS.
		WARM-AIR SUPPLY OUTLET. MAX. PERMITTED OPENING IN CEILING FIRE SEPARATION: 0.025m2 (.277 s.f.)
		EXISTING WALL TO REMAIN.
		PROPOSED WALL. DESIGNER TO PROVIDE ALL REQUIRED DETAILS TO DEMONSTRATE CONSTRUCTION
UP 3R		FIRE SEPARATION. PROVIDE CONSTRUCTION LABEL ALL REQUIRED SEPARATIONS WITH MINUTE RATINGS.
	$\sim$	WALL TYPE TAG. PROVIDE CONSTRUCTION DETAILS FOR ALL APPLICABLE WALLS.
	$\mathbb{R}^{2}$	EMERGENCY LIGHTING PER OBC 2012 DIV. B 9.9.12.3
		RETURN-AIR GRILLE. PROVIDED IN ALL FIRE COMPARTMENTS. SHALL NOT BE INSTALLED WITHIN FIRE SEPARATIONS.

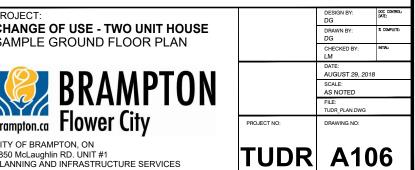

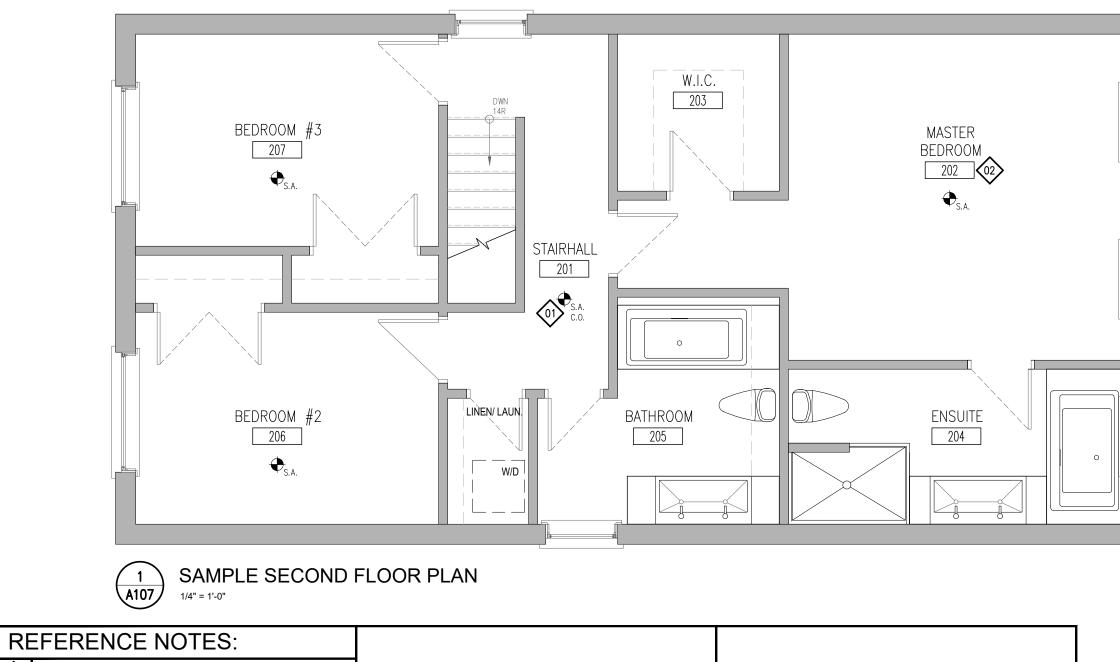





	LEGE	ND:			Π
	SYMBOL	DESCRIF	TION		
	€ <sub>S.A.</sub>	INTERCONNECTED SMOK	E ALARM WITH A \	/ISUAL SIGNAL	
		EXISTING WALL TO REM.	AIN.		
		PROPOSED WALL. DESIG DETAILS TO DEMONSTRA			
		FIRE SEPARATION. PRO REQUIRED SEPARATIONS			
		RETURN—AIR GRILLE PR DWELLINGS. SHALL NOT SEPARATIONS.			
/IPLE S	ECOND FLO			DESIGN BY: DG DRWN BY: DR CHECKED BY: LM DATE: AUGUST 29, 2018	DOC CONTROL DATE 1 COMPLETE
?/	RKAN	<b>NPTON</b>		SCALE: AS NOTED FILE: TUDR_PLAN.DWG	
<b>pton.ca</b> OF BRAM	Flower C	ity	PROJECT NO:	DRAWING NO:	


CITY OF BRAMPTON, ON 8850 McLaughlin RD. UNIT #1 PLANNING AND INFRASTRUCTURE SERVICES

TUDR A107

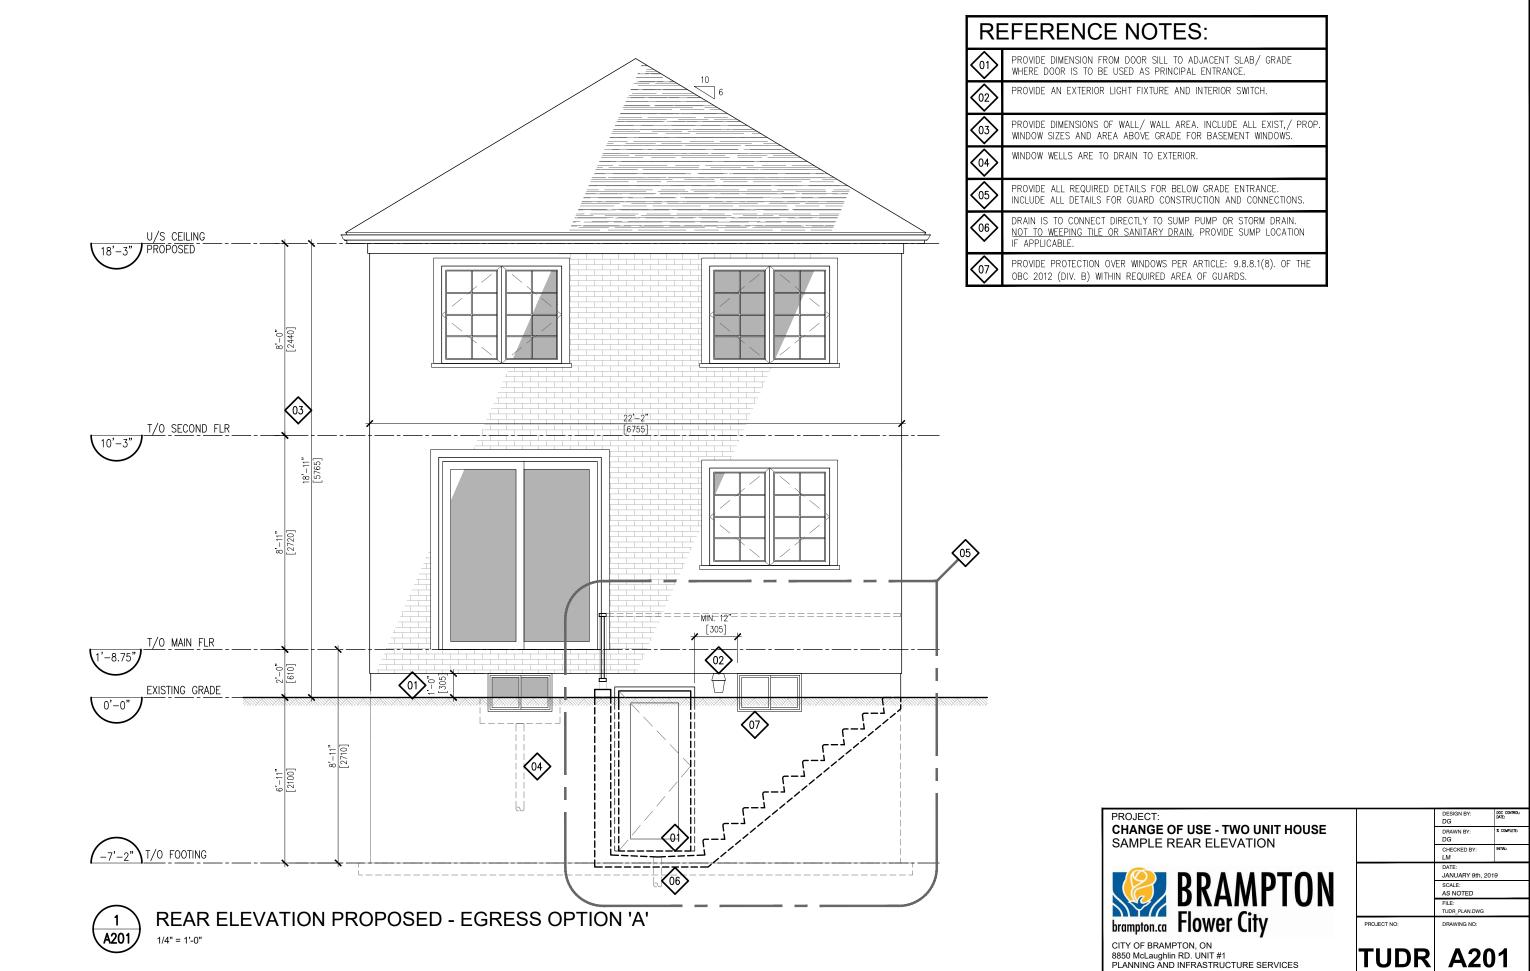

NOTES:
DOOR SILL TO ADJACENT SLAB/ GRADE D AS PRINCIPAL ENTRANCE.
T FIXTURE AND INTERIOR SWITCH.
ALL/ WALL AREA. INCLUDE ALL EXIST,/ PROP. BOVE GRADE FOR BASEMENT WINDOWS.
IN TO EXTERIOR.
AILS FOR BELOW GRADE ENTRANCE. GUARD CONSTRUCTION AND CONNECTIONS.
CTLY TO SUMP PUMP OR STORM DRAIN. ANITARY DRAIN. PROVIDE SUMP LOCATION

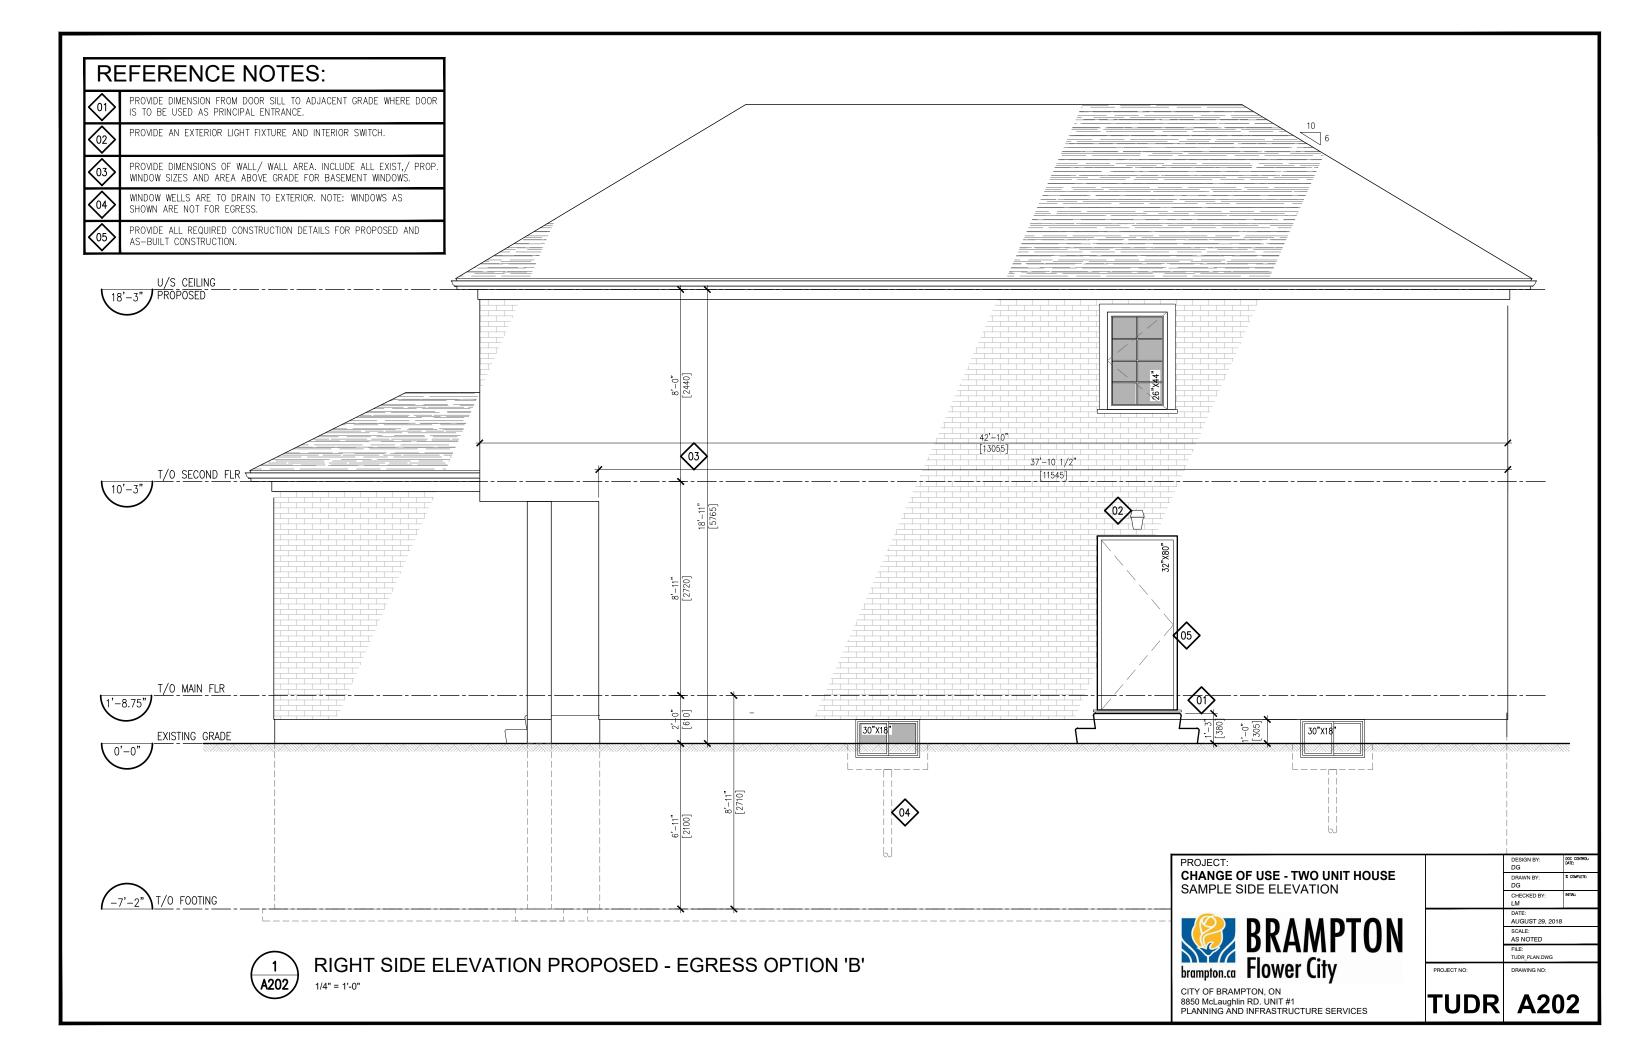

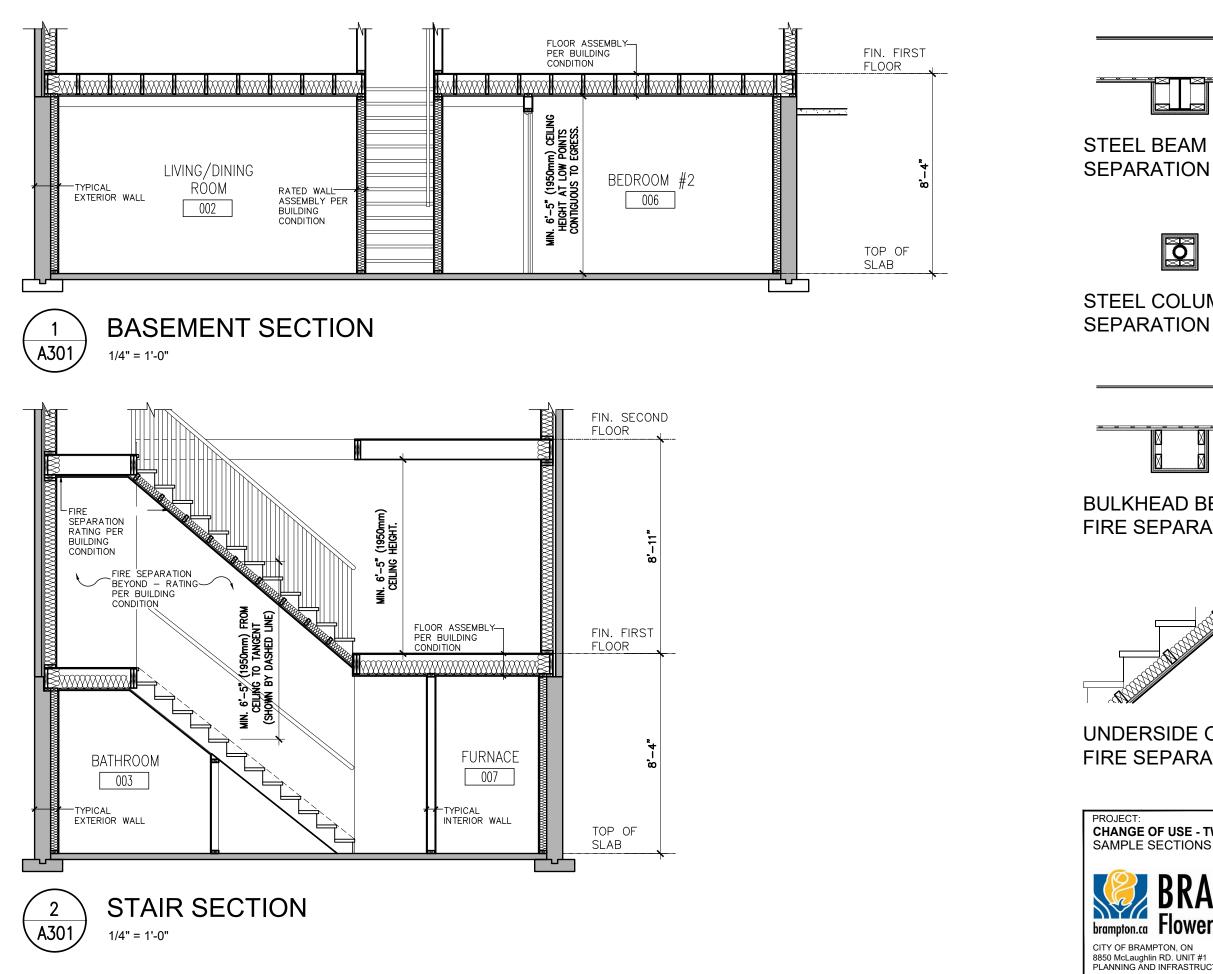

EEL COLUMN PARATION	2"x4" WOOD STUD 2 LAYERS TYPE '> GYPSUM BOARD RATING PER BUILD CONDITION	Κ'		
LKHEAD BELOW RE SEPARATION	FIRE SEPARATION CEILING ABOVE 2"x4" WOOD STUD 1/2" GYPSUM BOA			
2"x4" WOOD STUDS TO SUPPORT CEILING SOUND INSULATION (OPTIONAL) 2 LAYERS TYPE 'X' GYPSUM BOARD RATING PER BUILDING CONDITION				
DJECT: MANGE OF USE - TWO UNIT HOUSE MPLE SECTIONS BRANPTON BRANPTON, ON OF BRAMPTON, ON McLaughlin RD. UNIT #1	PROJECT NO:	DESIGN BY: DOC CONTROL: DS DRAWN BY: & COMINIC DS CHECKED BY: MTWL: LM DATE: AUGUST 29, 2018 SCALE: AS NOTED FILE: TUGP, PLANDWG DRAWING NO:		
NNING AND INFRASTRUCTURE SERVICES	TUDR	AJUI		

2"x4" WOOD FRAMING

2 LAYERS TYPE 'X'

GYPSUM BOARD RATING PER BUILDING CONDITION



PRC CH/ WA

WALL TYPES DEMONSTRATED ON THIS DRAWING ARE BASED ON WALL CONSTRUCTION DETAILS SPECIFIED IN THE SUPPLEMENTARY STANDARD SB-3. DESIGNER IS REQUIRED TO SPECIFY THE MINUTE RATING AND CONSTRUCTION OF ALL **REQUIRED FIRE SEPARATIONS.** 

FRR - 30 MIN. STC - N/A **BUILDING CONDITION B** 

WALL ASSEMBLY W1c

2"x4" OR 2"x6" @ 16" O/C WOOD STUDS ENTIRE STUD CAVITY FILLED WITH SOUND INSULATION 1/2" GYPSUM BOARD

1/2" GYPSUM BOARD

WOOD STUDS

(OPTIONAL)

**TYPICAL INTERIOR WALL** 

2"x4" OR 2"x6" @ 16" O/C

ENTIRE STUD CAVITY FILLED

WITH SOUND INSULATION

1/2" GYPSUM BOARD

1/2" GYPSUM BOARD

EXISTING PLYWOOD, OSB, OR

WOOD JOISTS OR WOOD I-JOISTS

(OPTIONAL 6" SOUND INSULATION)

RESILIENT CHANNELS @ 610mm O.C. 15.9mm TYPE 'X' GYPSUM BOARD

SPACED NOT MORE THAN 610mm O.C. NO ABSORPTIVE MATERIAL IN CAVITY

WAFERBOARD SUBFLOOR

FLOOR ASSEMBLY F8b FRR - 30 MIN. STC - 43 **BUILDING CONDITION B** 

FLOOR ASSEMBLY F9h FRR - 45 MIN. STC - 53 **BUILDING CONDITION A** 

WOOD STUDS

15.5mm PLYWOOD, OSB, OR

WOOD JOISTS OR WOOD I-JOISTS

ABSORPTIVE MATERIAL IN CAVITY

RESILIENT CHANNELS @ 610mm O.C.

SPACED NOT MORE THAN 610mm O.C.

2 LAYERS 12.7mm TYPE 'X' GYPSUM BOARD

5/8" TYPE 'X' GYPSUM BOARD

2"x4" OR 2"x6" @ 16" O/C

3 1/2" SOUND INSULATION

2 LAYERS 5/8" TYPE 'X'

@ 16" OR 24" O/C

GYPSUM BOARD

WALL ASSEMBLY W4a

FRR - 1 HOUR STC - 51

**BUILDING CONDITION A** 

WOOD STUDS

**TYPICAL EXTERIOR WALL** 

RESILIENT METAL CHANNELS

EXTERIOR FOUNDATION WALL


2"x4" OR 2"x6" @ 16" O/C

MIN. R12 BATT INSULATION

1/2" GYPSUM BOARD

6 MIL. POLY VAPOUR BARRIER

WAFERBOARD SUBFLOOR

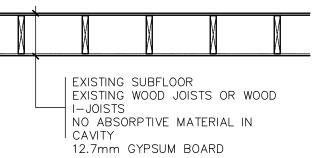


# EXISTING FLOOR ASSEMBLY FRR - 15 MIN. STC - N/A **BUILDING CONDITION C**





1/2" GYPSUM BOARD 2"x4" OR 2"x6" @ 16" O/C WOOD STUDS ENTIRE STUD CAVITY FILLED WITH SOUND INSULATION (OPTIONAL) 1/2" GYPSUM BOARD

# **EXISTING RATED WALL** FRR - 30 MIN. STC - N/A **BUILDING CONDITION C**


DJECT:		DESIGN BY: DS	DOC CONTROL: DATE:
ANGE OF USE - TWO UNIT HOUSE		DRAWN BY: DS	% COMPLETE:
		CHECKED BY: LM	INITIAL:
		DATE: AUGUST 29, 2018	
浸 BRAMPTON		SCALE: AS NOTED	
		FILE: TUDR_PLAN.DWG	
npton.ca Flower City	PROJECT NO:	DRAWING NO:	
	TUDR	A30	2

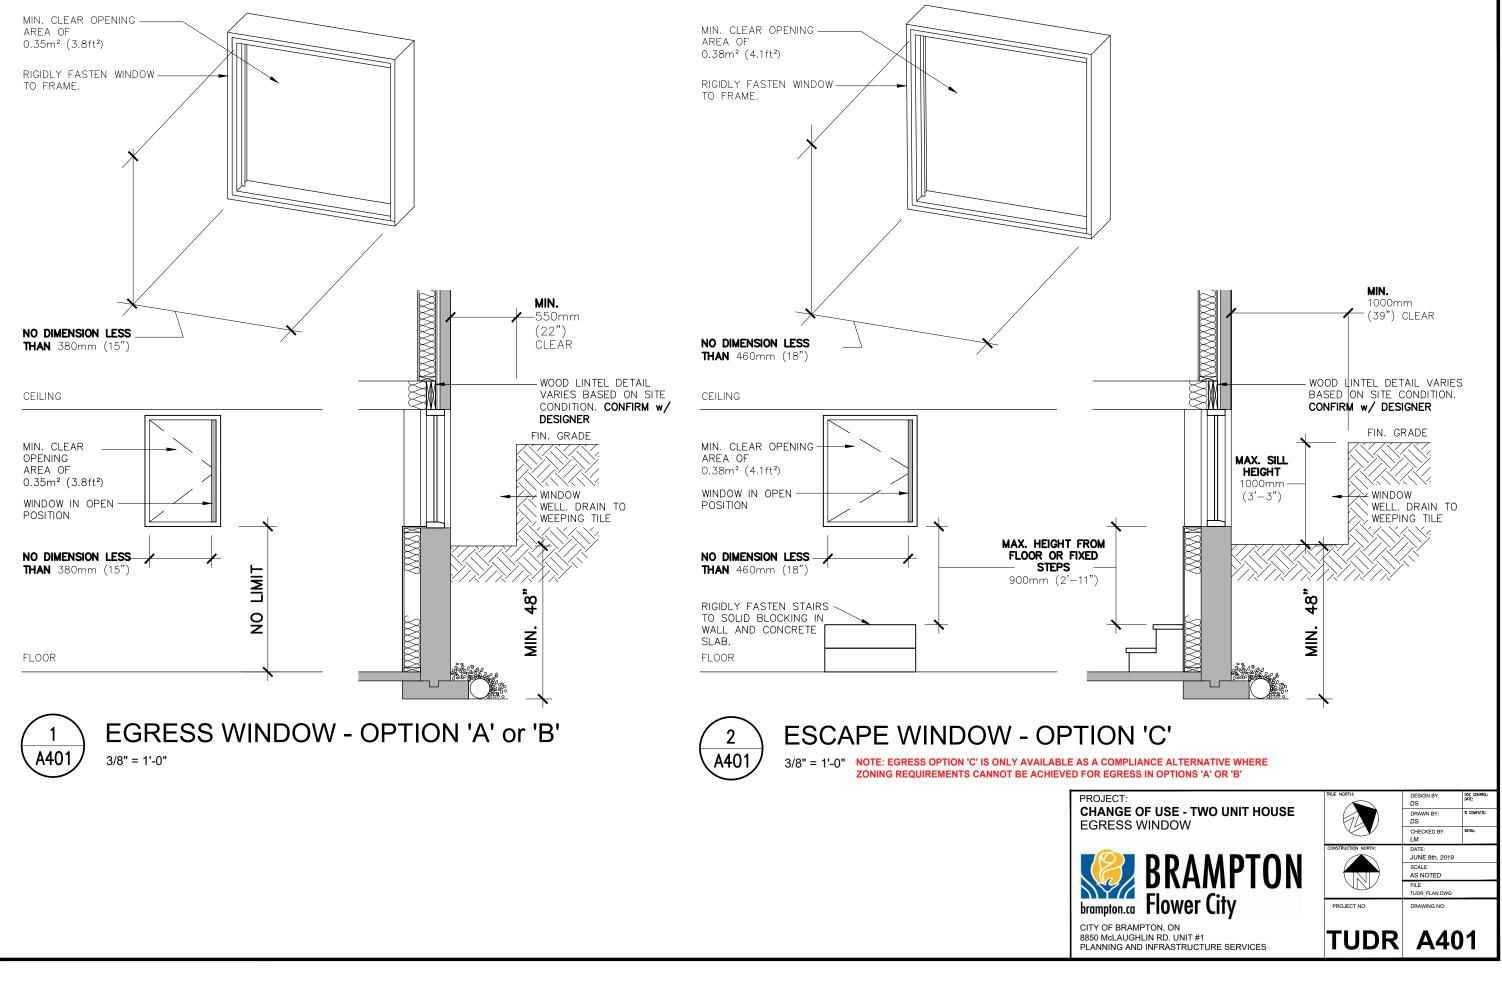

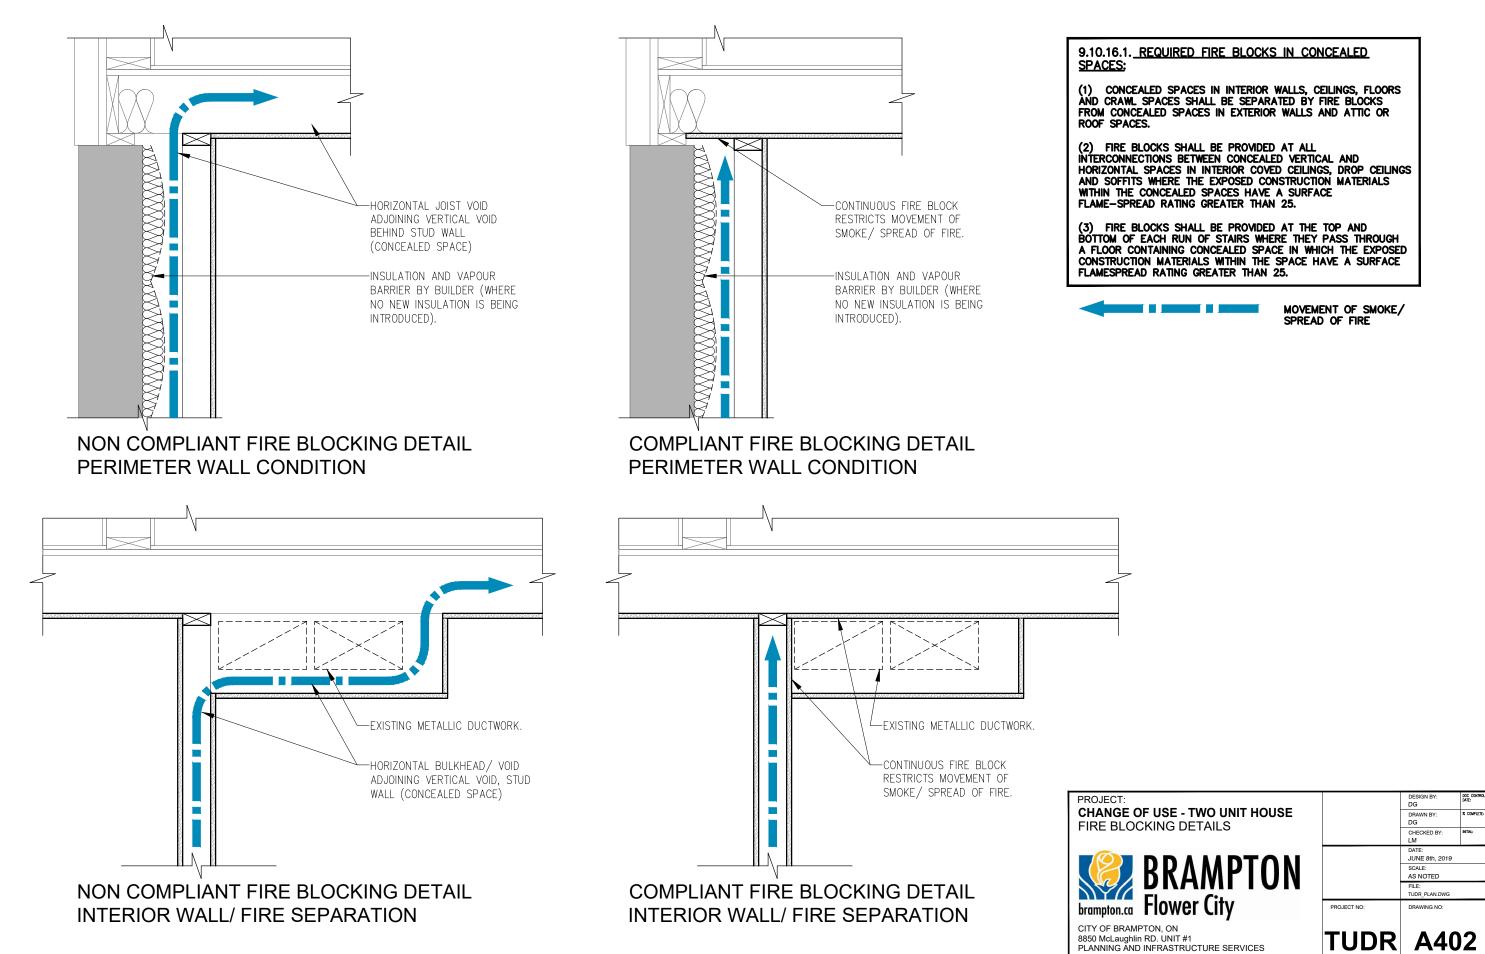

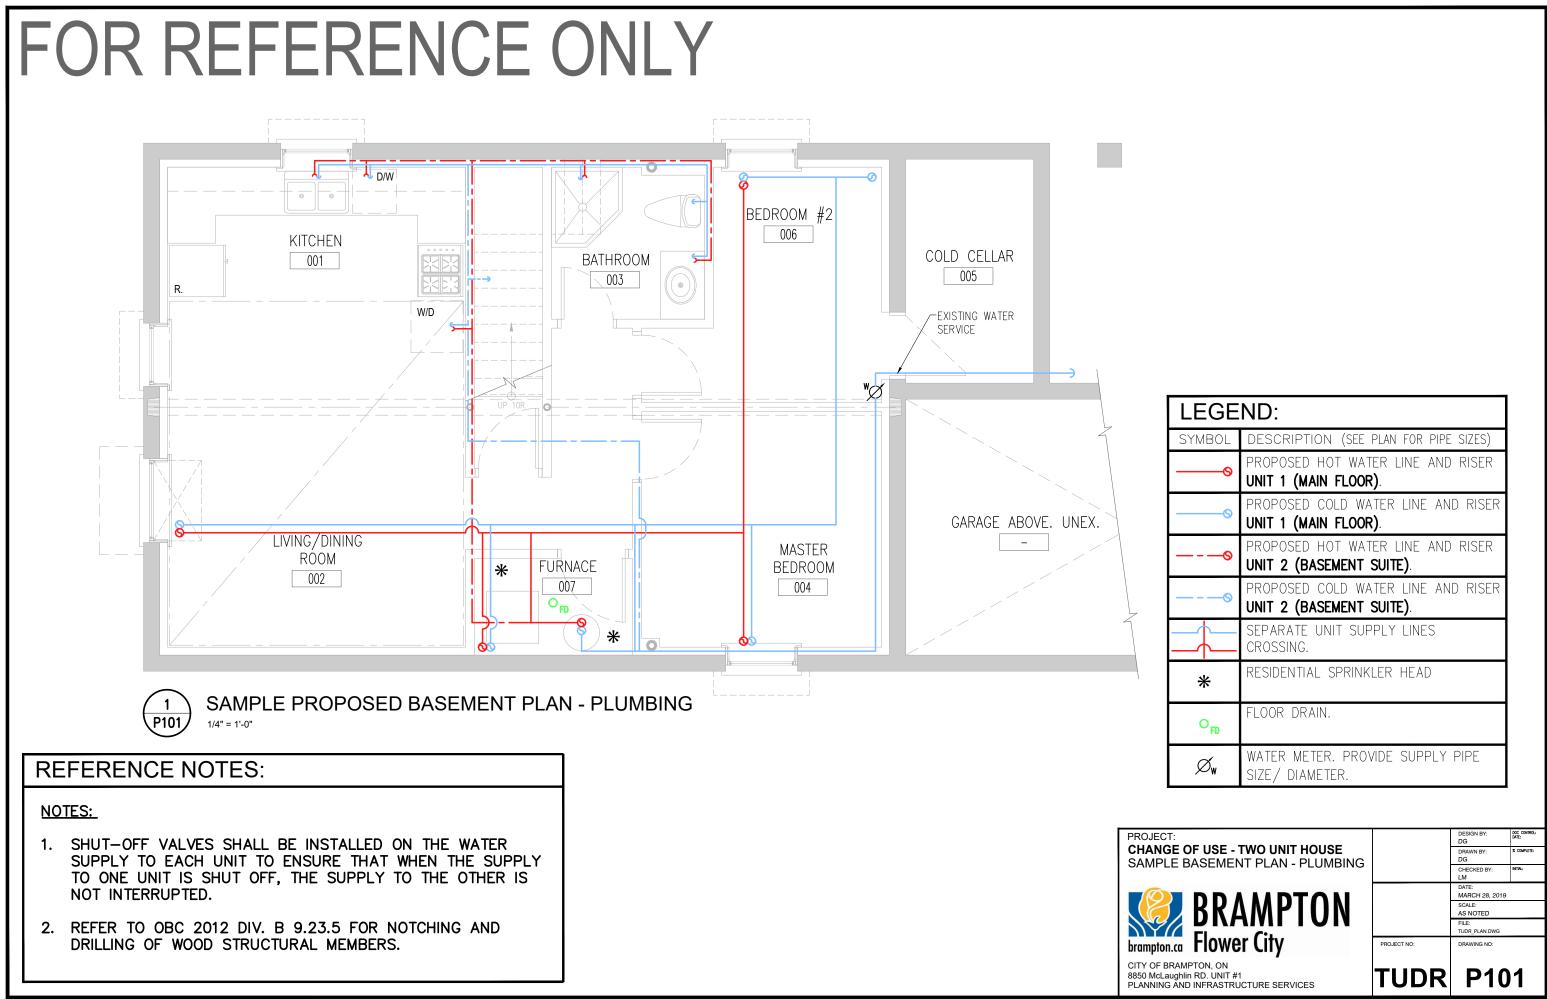

LEGE	ND:
SYMBOL	DESCRIPTION (SEE PLAN FOR PIPE SIZES)
Ø	PROPOSED HOT WATER LINE AND RISER UNIT 1 (MAIN FLOOR).
Ø	proposed cold water line and riser <b>unit 1 (main floor)</b> .
Ø	PROPOSED HOT WATER LINE AND RISER UNIT 2 (BASEMENT SUITE).
Ø	PROPOSED COLD WATER LINE AND RISER UNIT 2 (BASEMENT SUITE).
$\left\{ \left\{ \right\} \right\}$	SEPARATE UNIT SUPPLY LINES CROSSING.
*	RESIDENTIAL SPRINKLER HEAD
O <sub>FD</sub>	FLOOR DRAIN.
$\varnothing_{w}$	WATER METER. PROVIDE SUPPLY PIPE SIZE/ DIAMETER.

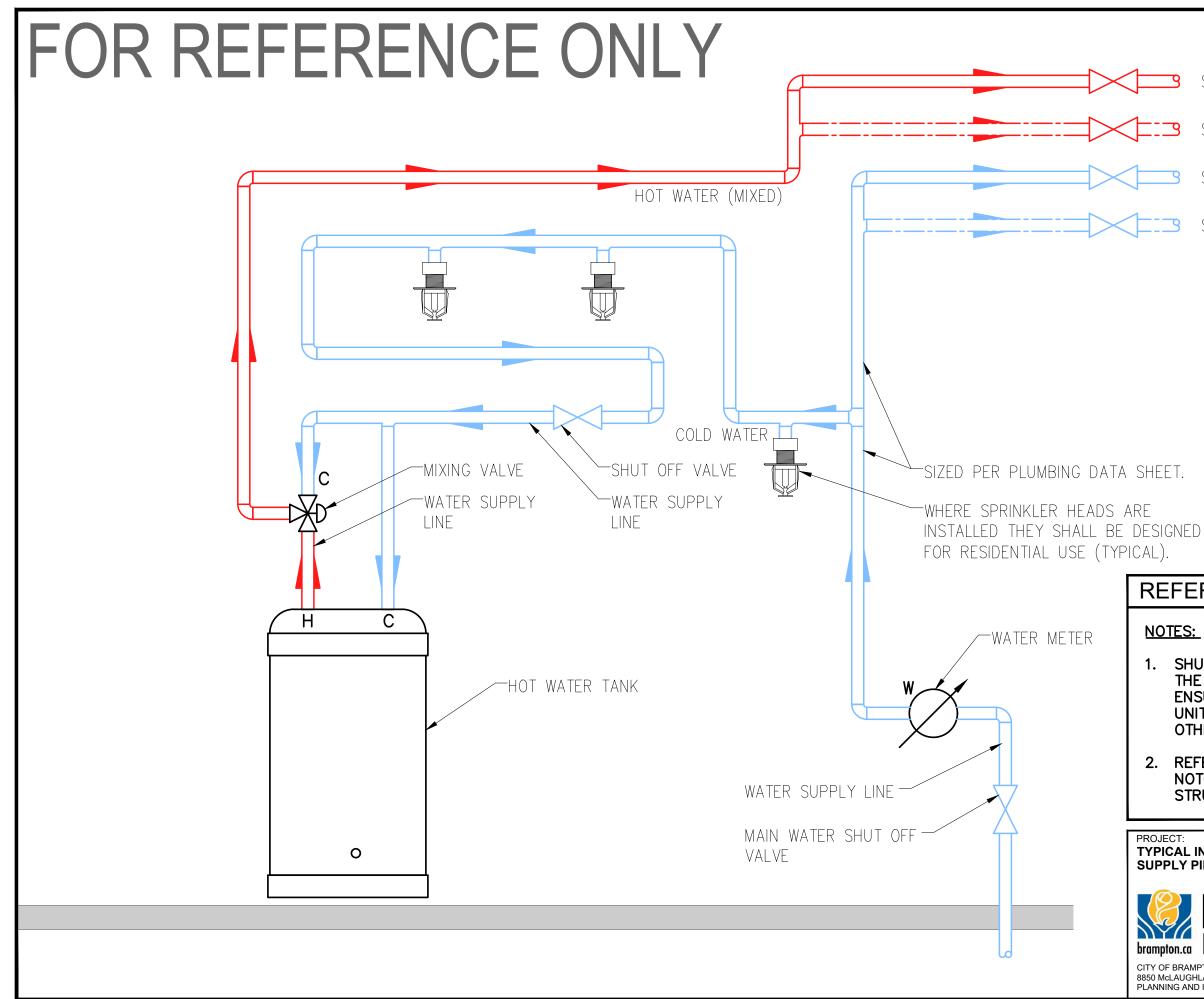

- SHUT OFF VALVE (HOT) UNIT 1
- SHUT OFF VALVE (HOT) UNIT 2 3
- SHUT OFF VALVE (COLD) UNIT 1
- SHUT OFF VALVE (COLD) UNIT 2

# **REFERENCE NOTES:**

# NOTES:

- 1. SHUT-OFF VALVES SHALL BE INSTALLED ON THE WATER SUPPLY TO EACH UNIT TO ENSURE THAT WHEN THE SUPPLY TO ONE UNIT IS SHUT OFF, THE SUPPLY TO THE OTHER IS NOT INTERRUPTED.
- 2. REFER TO OBC 2012 DIV. B 9.23.5 FOR NOTCHING AND DRILLING OF WOOD STRUCTURAL MEMBERS.

DJECT:		DESIGN BY: JR	DOC CONTROL: DATE:
PICAL INSTALLATION OF WATER		DRAWN BY: DG	% COMPLETE:
		CHECKED BY: LM	INITIAL:
		DATE: MARCH 28, 2019	
BRAMPTON		SCALE: AS NOTED	
		FILE: TUDR_PLAN.DWG	
mpton.ca Flower City	PROJECT NO:	DRAWING NO:	
Y OF BRAMPTON, ON DMCLAUGHLAN RD, UNIT #1	חחוד		2
NNING AND INFRASTRUCTURE SERVICES	TUDR	P10	Z